

* REFER TO DESIGN DETAILS: ALLAN BLOCK TYPICAL REINFORCED WALL APPLICATION FOR ALL OTHER NOTES, DETAILS AND SPECIFICATIONS.

COLUMN TUBE OR PVC PIPE TO BE INSTALLED DURING WALL CONSTRUCTION (AFTER WALL CONSTRUCTION - POST FOOTING WILL REQUIRE HAND EXCAVATION AS TO NOT DAMAGE GEOGRID)

CUT OR DISPLACE GEOGRID AROUND COLUMN TUBE OR PVC PIPE

ALLAN BLOCK UNIT

NON-WIND LOADED FENCE OR RAILING


FENCE OR RAILING HEIGHT


CONCRETE POST FOOTING

FILTER FABRIC TO BE PLACED BETWEEN TOPSOIL AND WALL ROCK

POST EMBEDMENT DEPTH

TOP GEOGRID LAYER MUST BE WITHIN THE TOP THREE COURSES. ITS LENGTH MUST CONSIDER THE FENCE STABILITY.

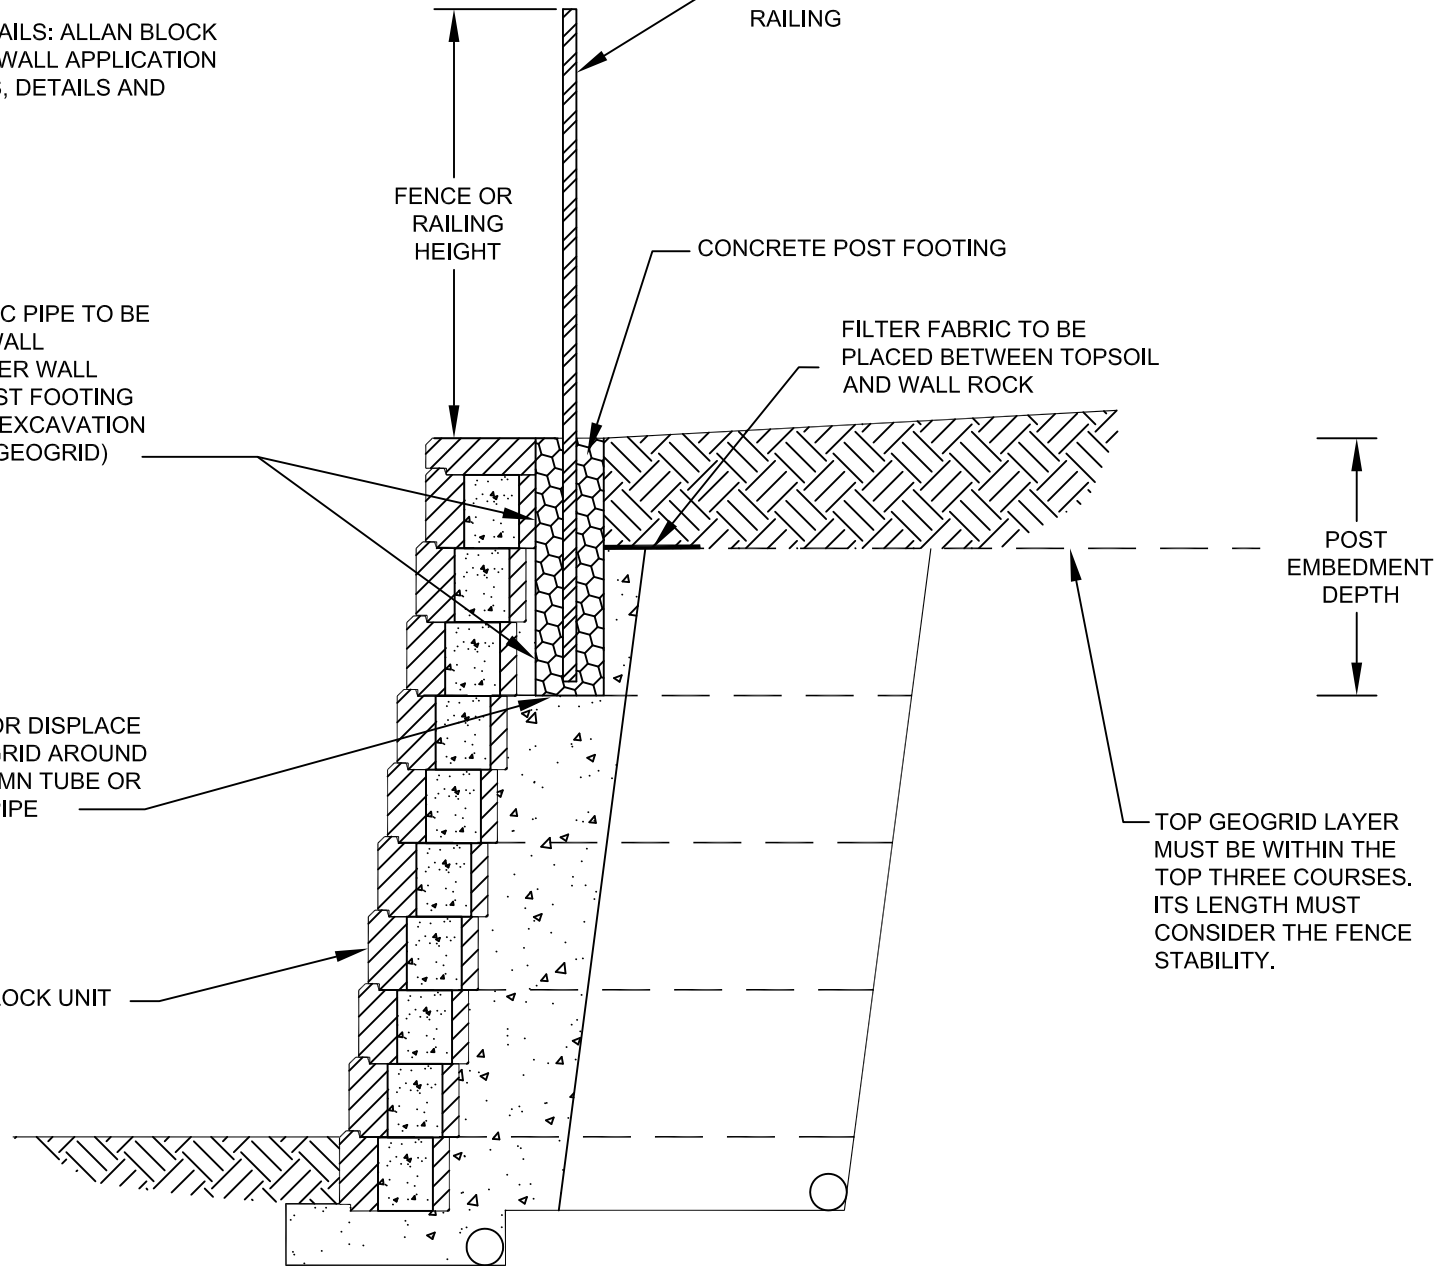

Designed By:	Title:	NO WIND FENCE WALL SECTION 1		Date:
Checked By:	 <p>The purpose of this drawing is for preliminary design only. This drawing should not be used for final design or construction without the certification of a professional engineer registered in the state in which the wall will be built. The accuracy and use of details contained in this document are the sole responsibility of the user. The user must verify each detail for accuracy as they pertain to their particular project. © 2005 Allan Block</p>			Project No:
Scale: NOT TO SCALE				Drawing No: